



FRONT ELEVATION

TYPE B 296 PELMET WITH TYPE C SIDE CHANNELS

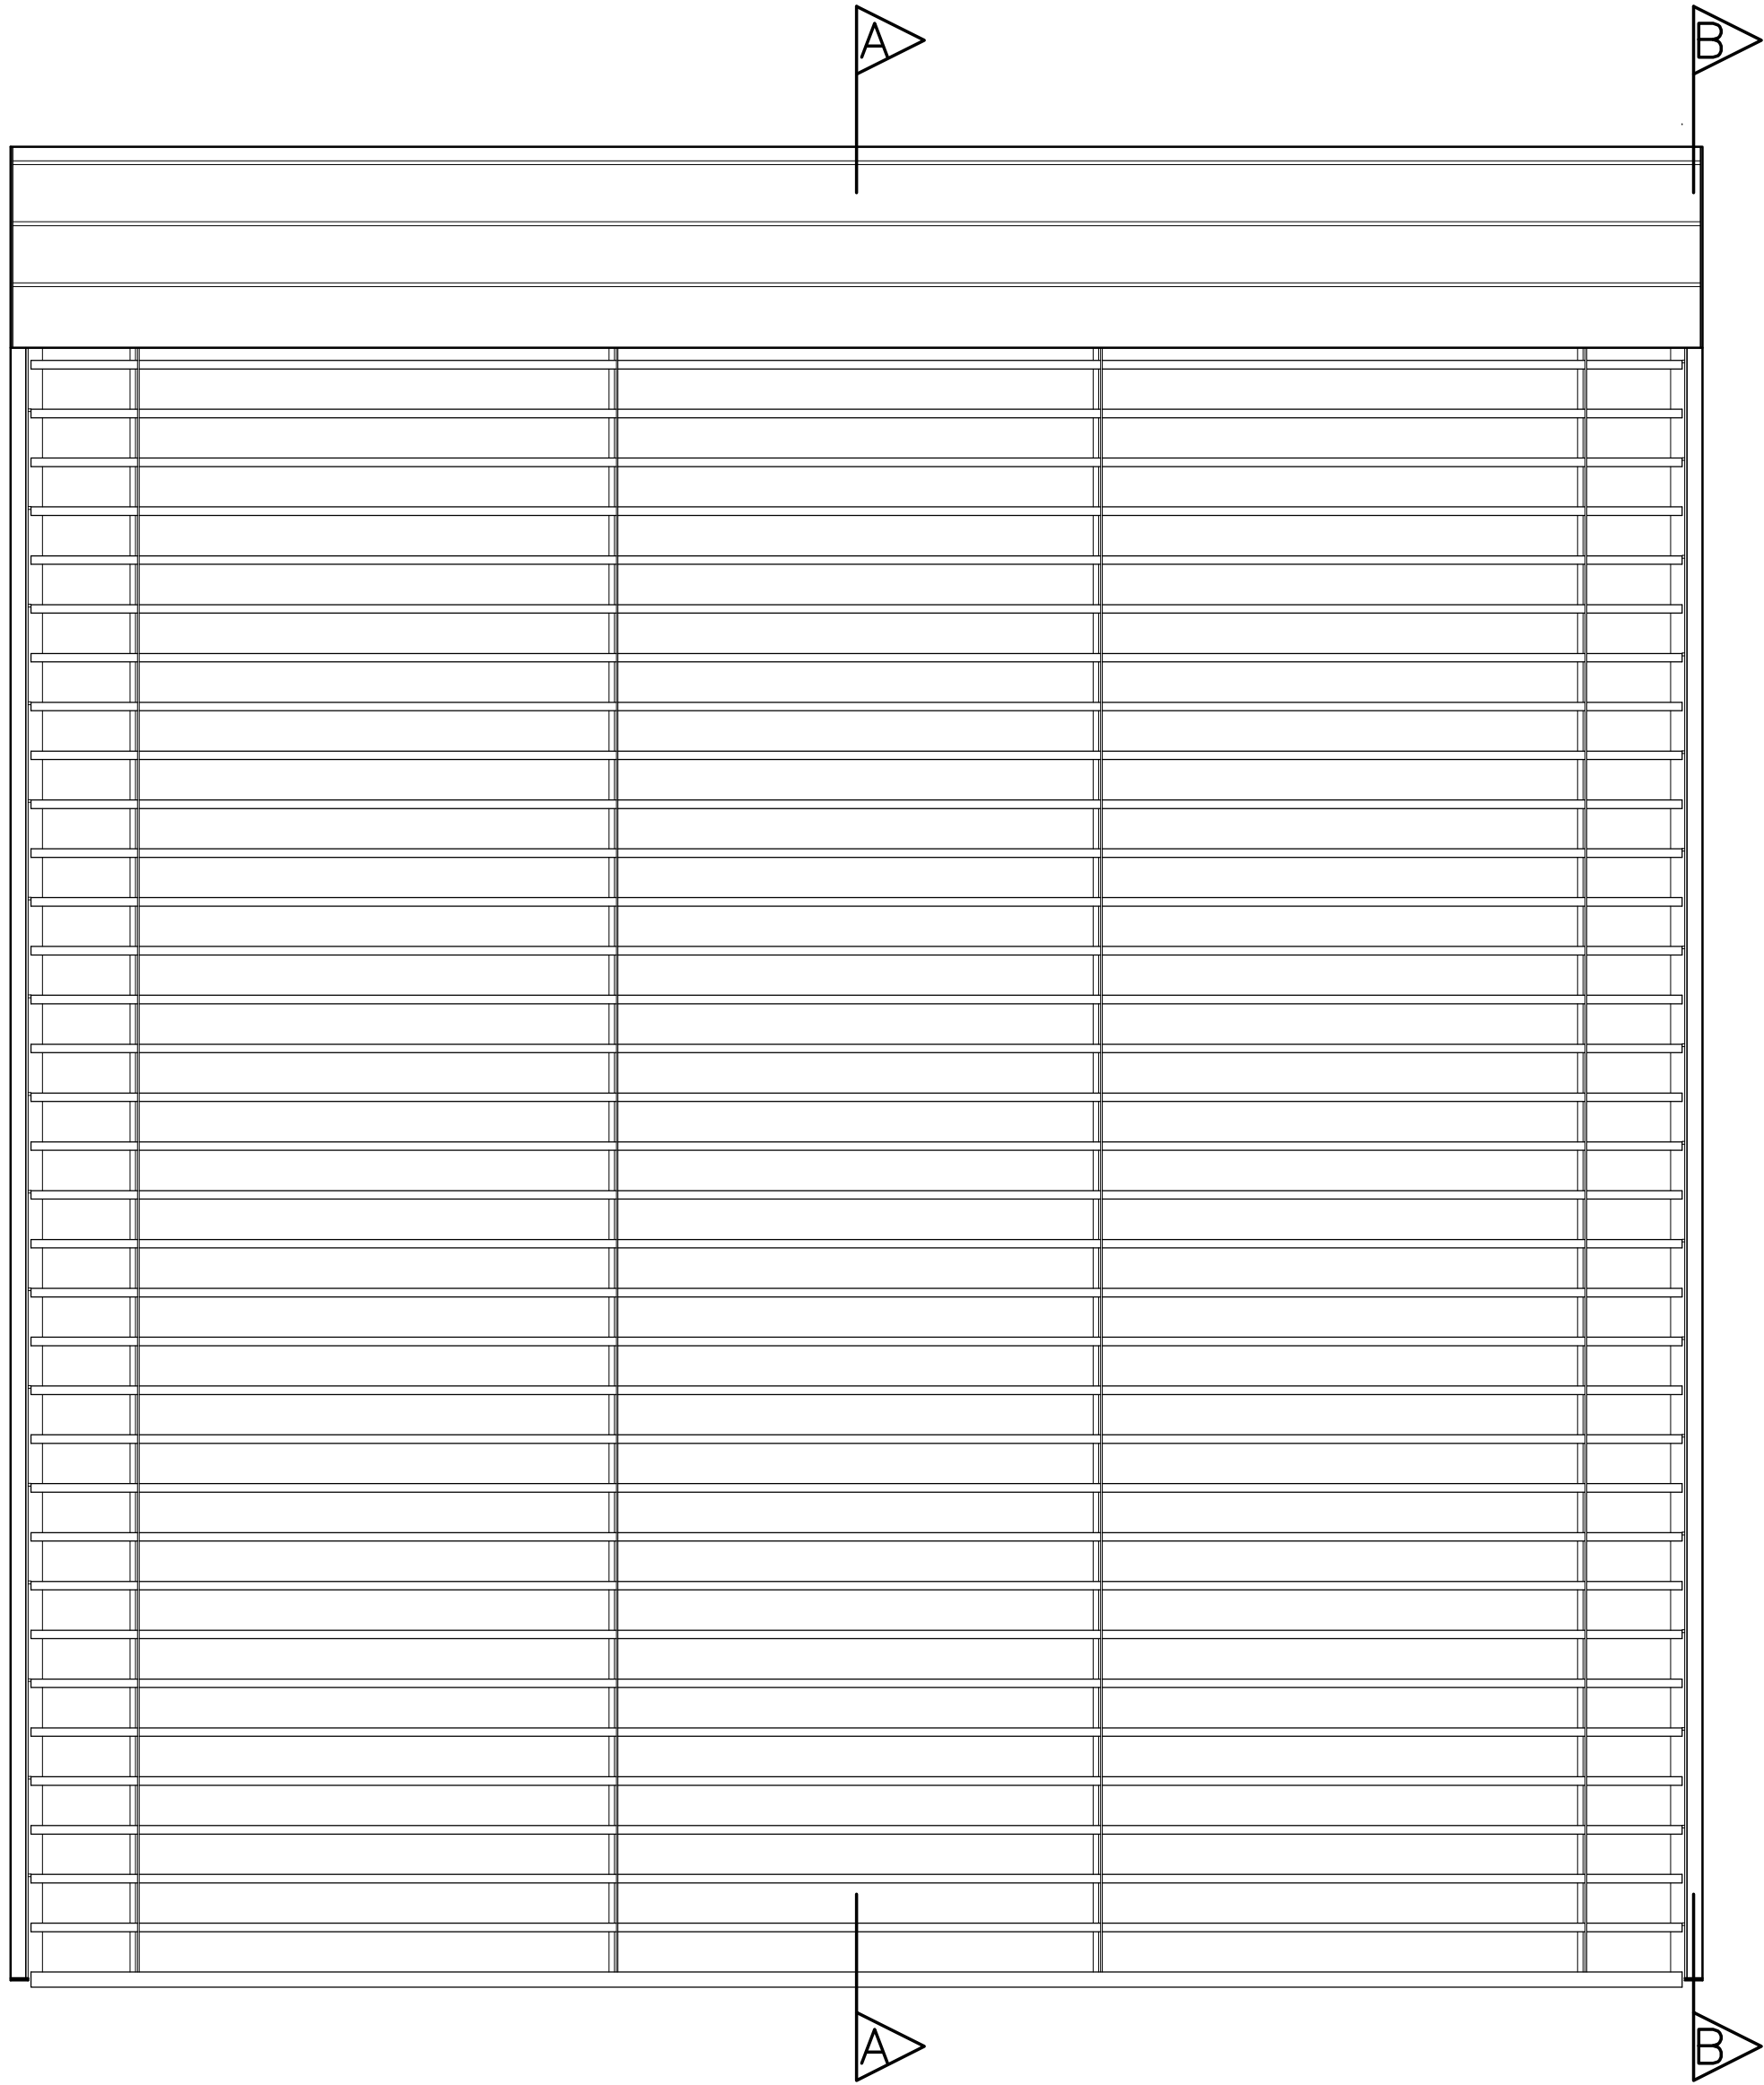


SECTION A-A

LOWERED

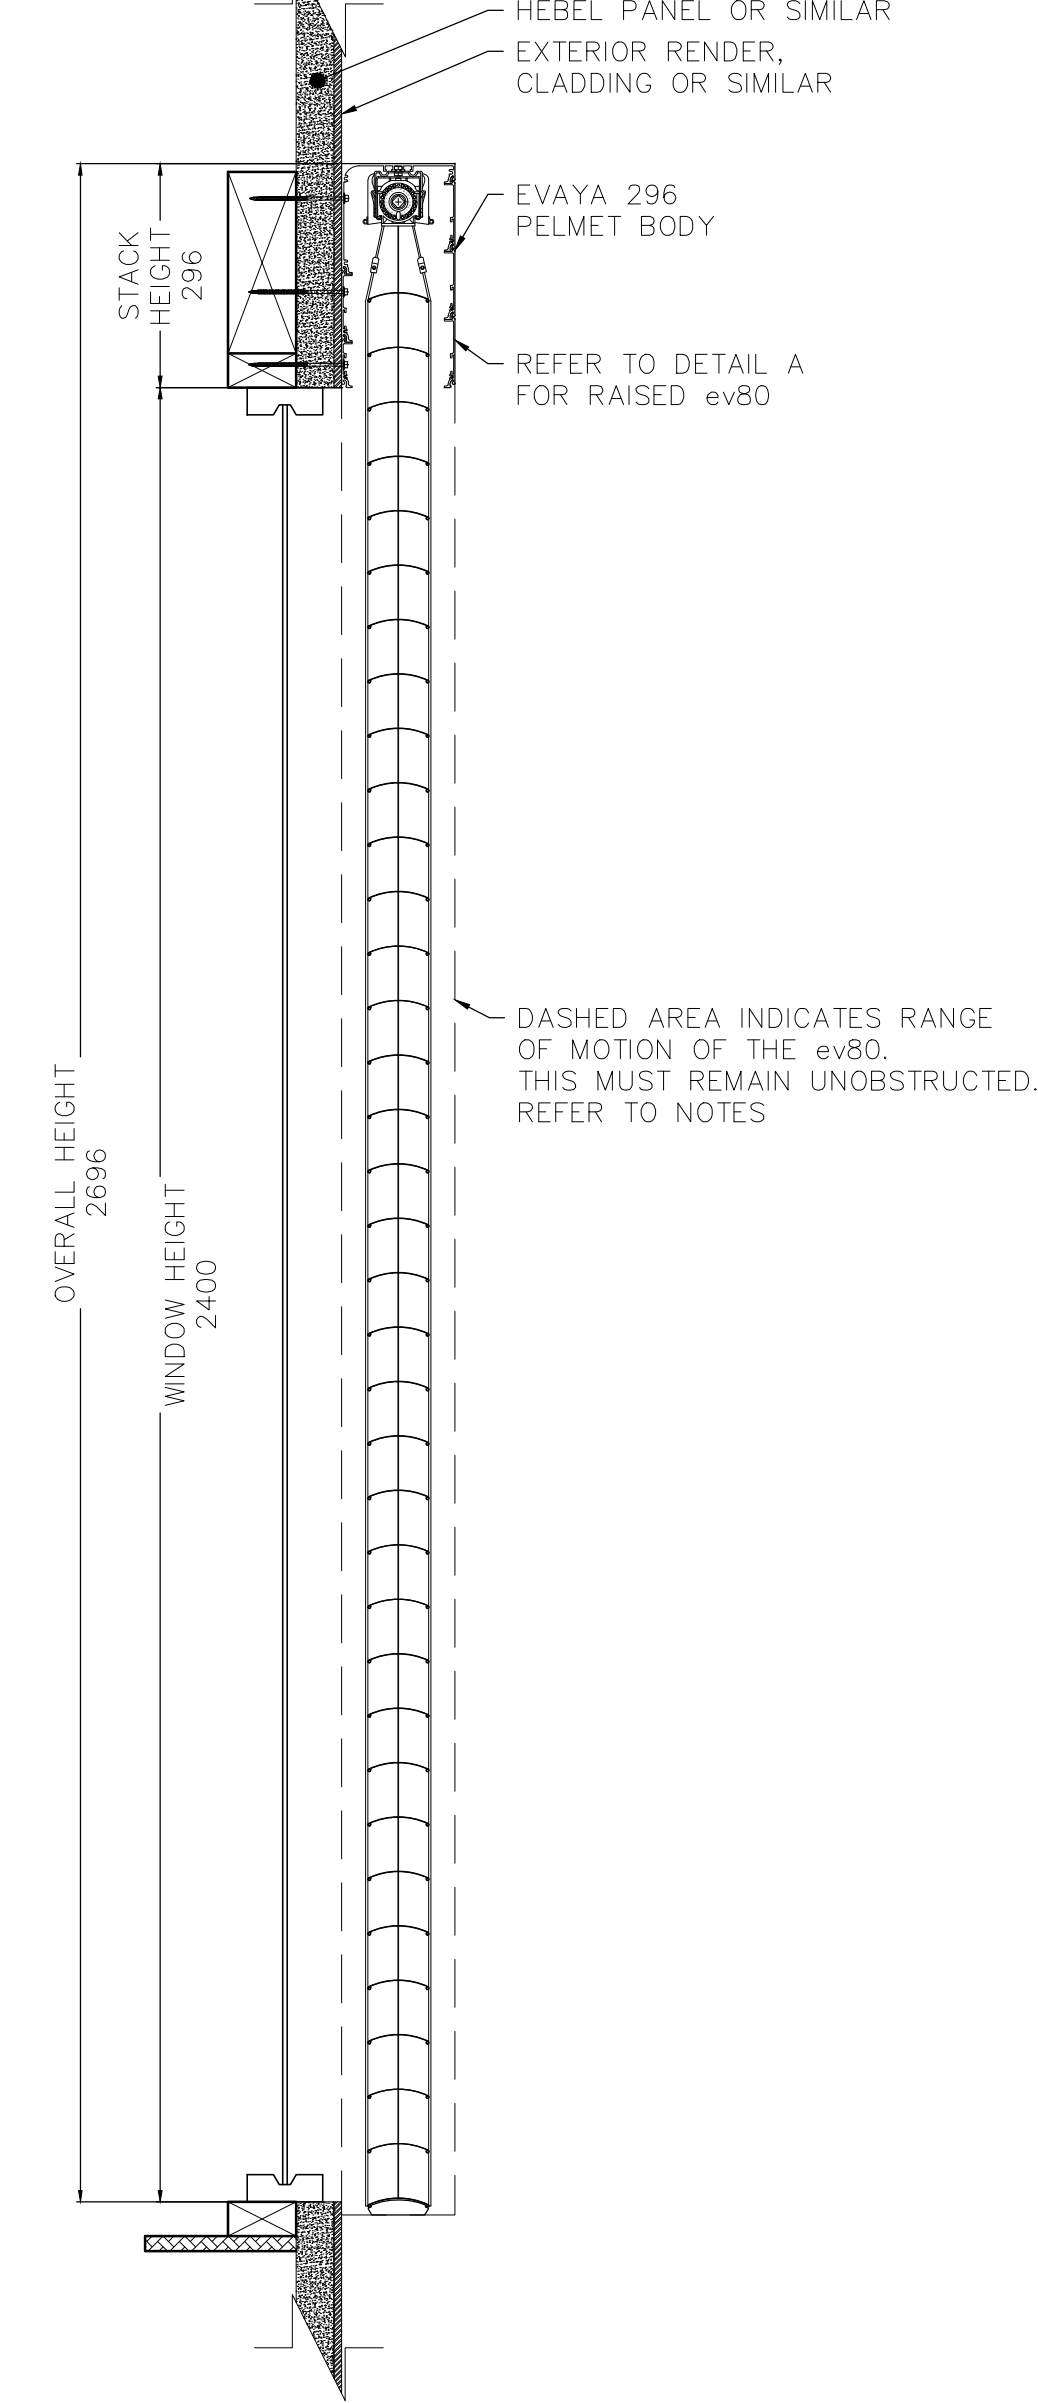


SECTION B-B

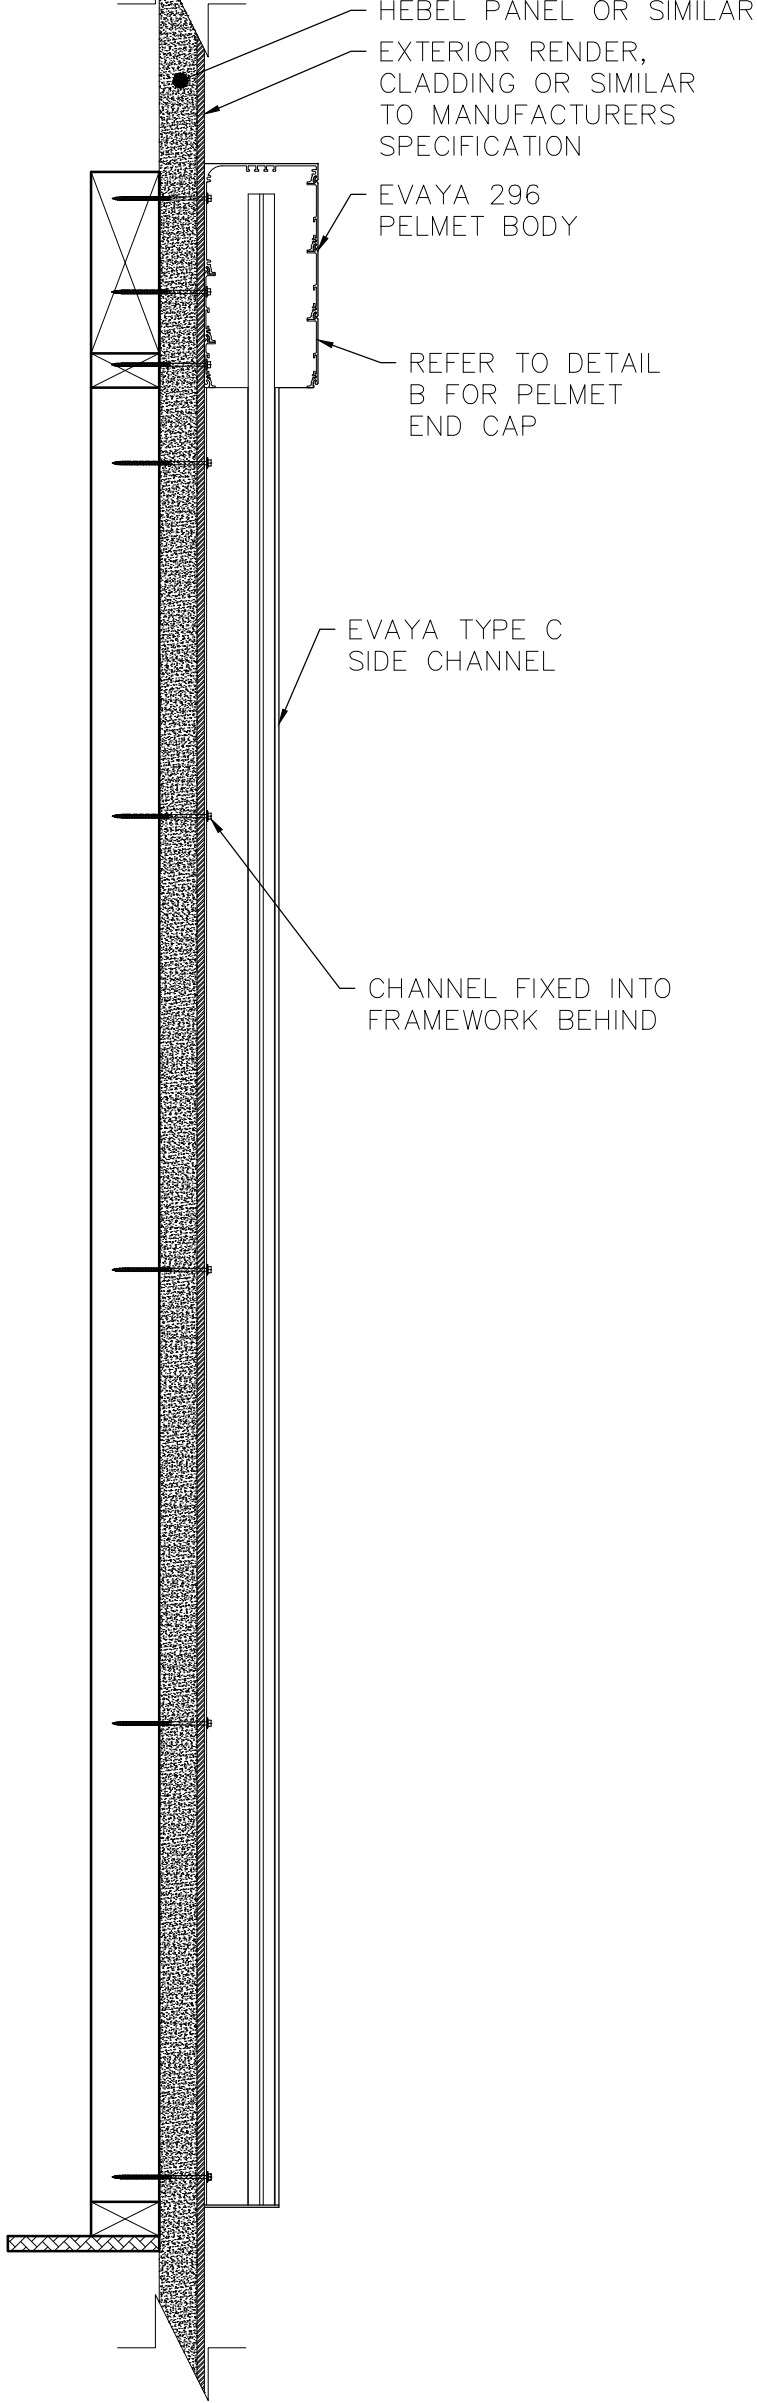


PELMET PROFILE

SCALE 1:1

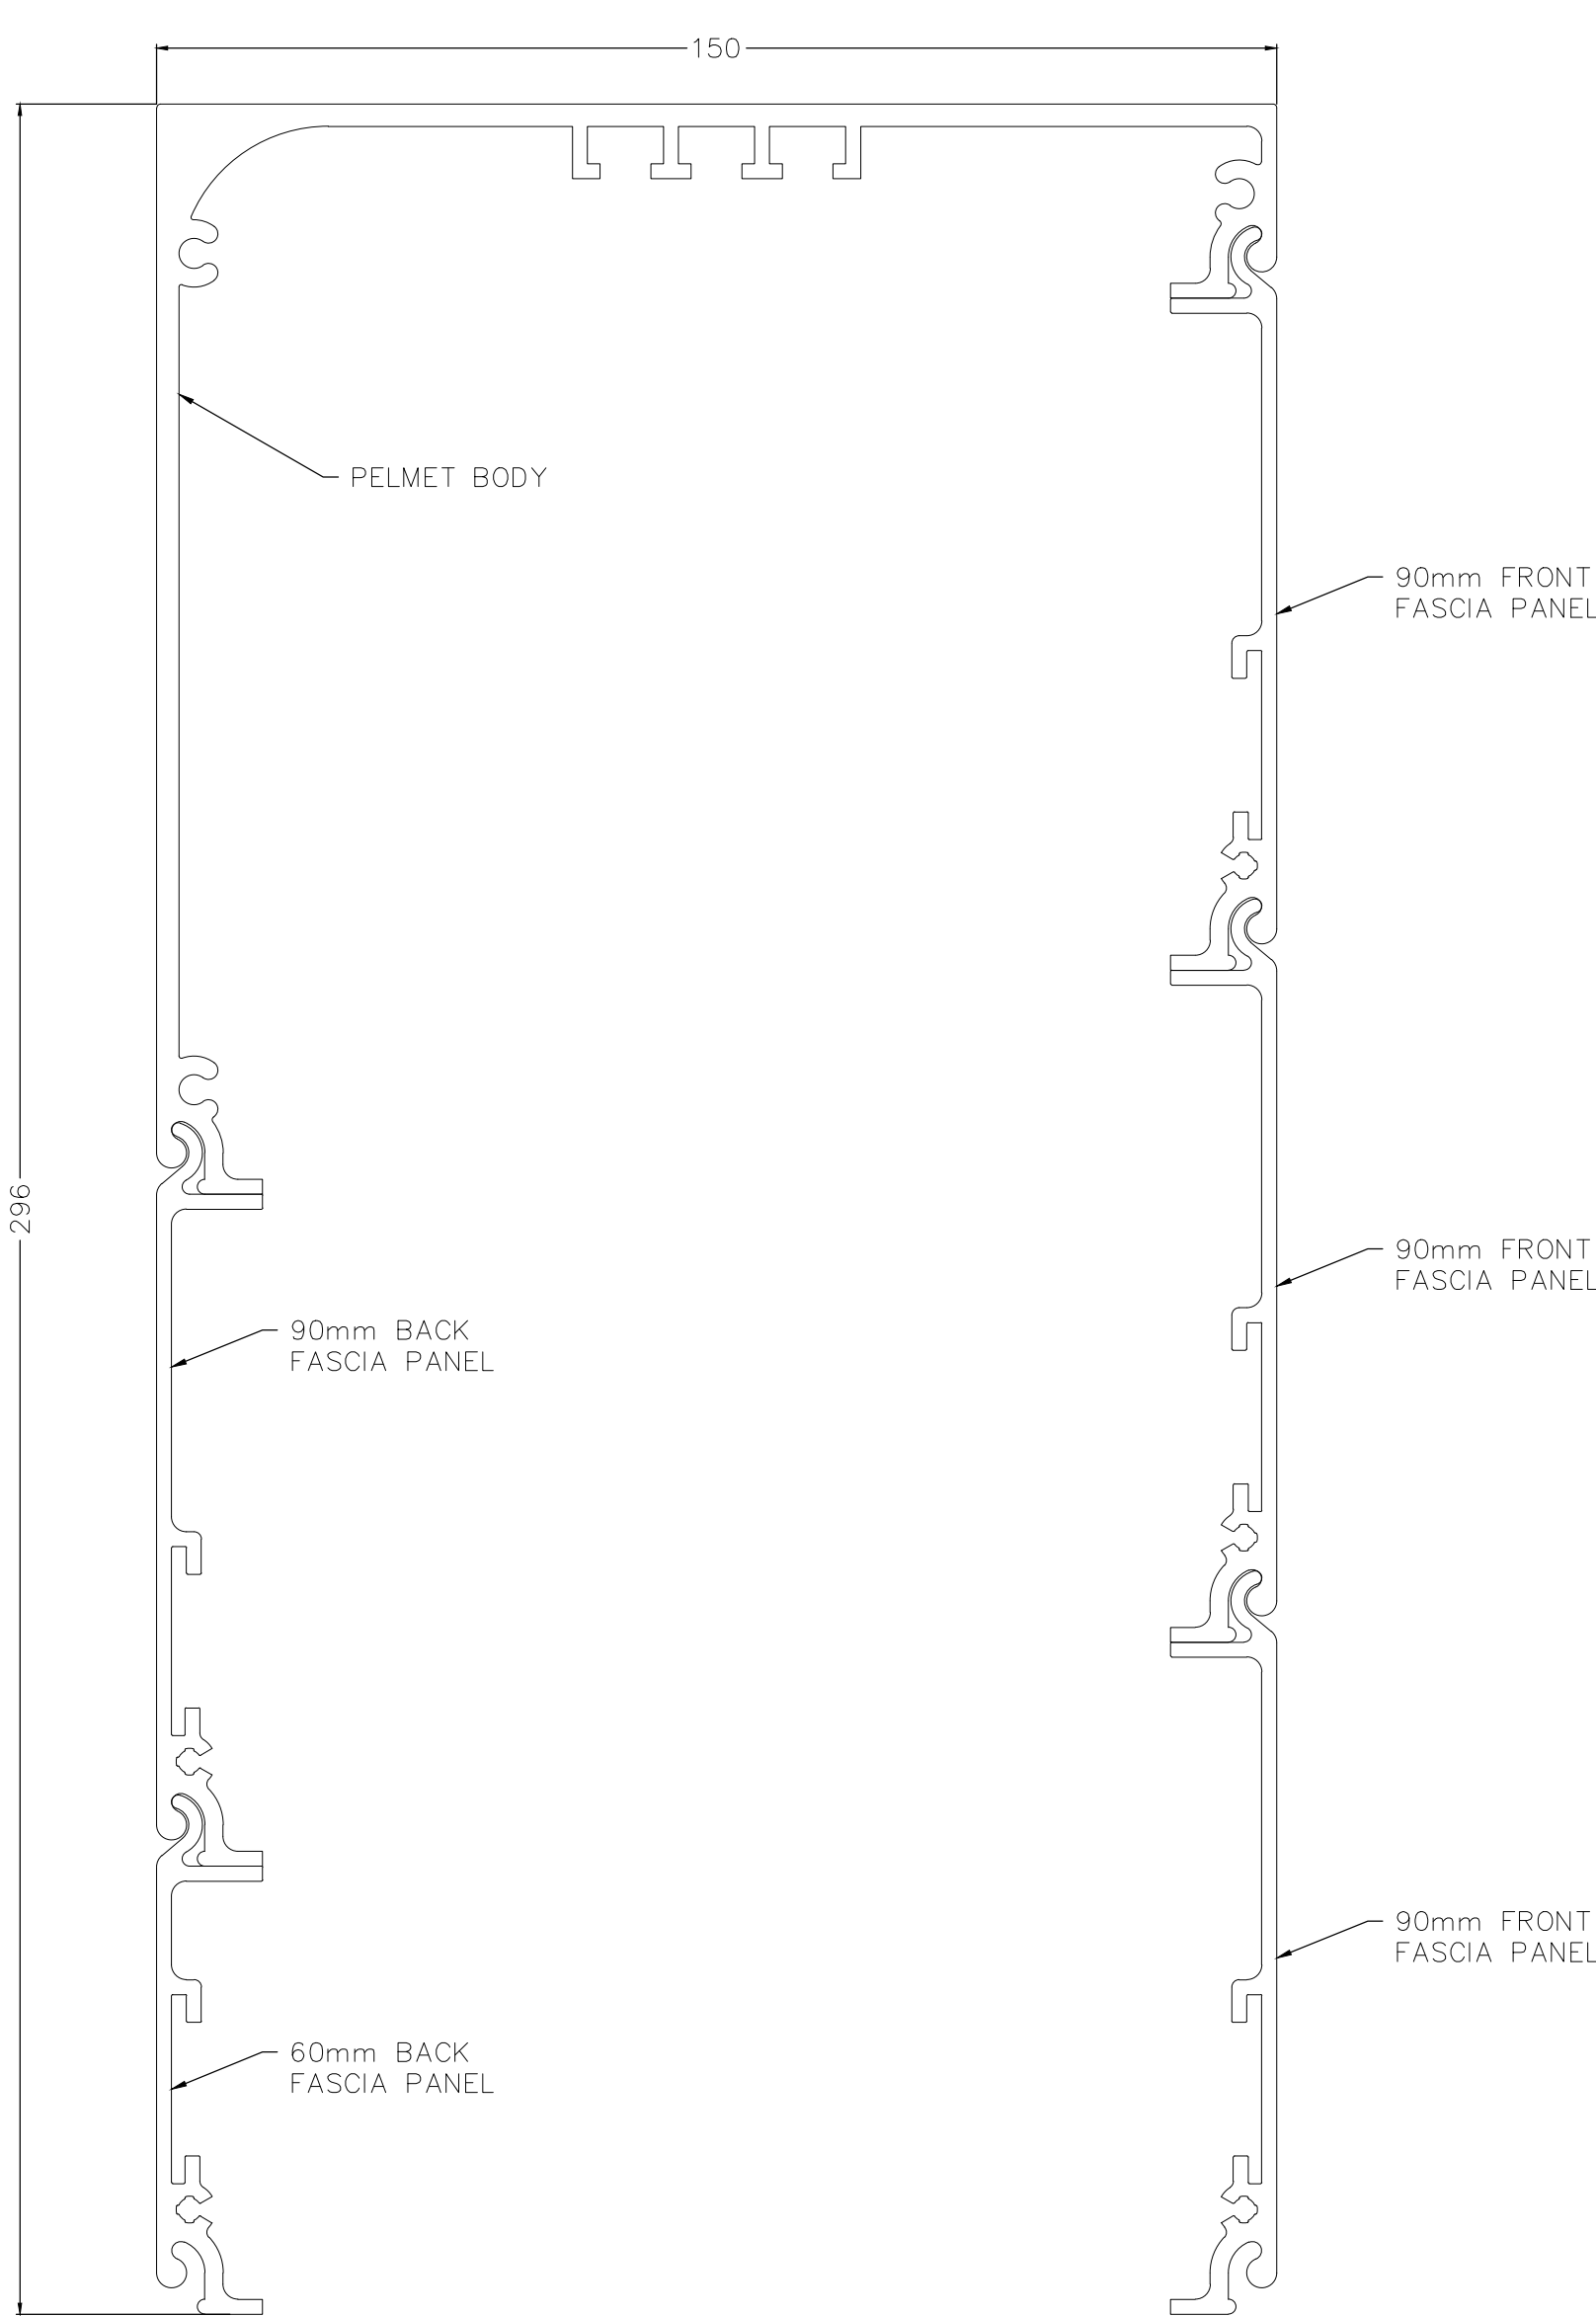


DETAIL A

ev80 RAISED
SCALE 1:5

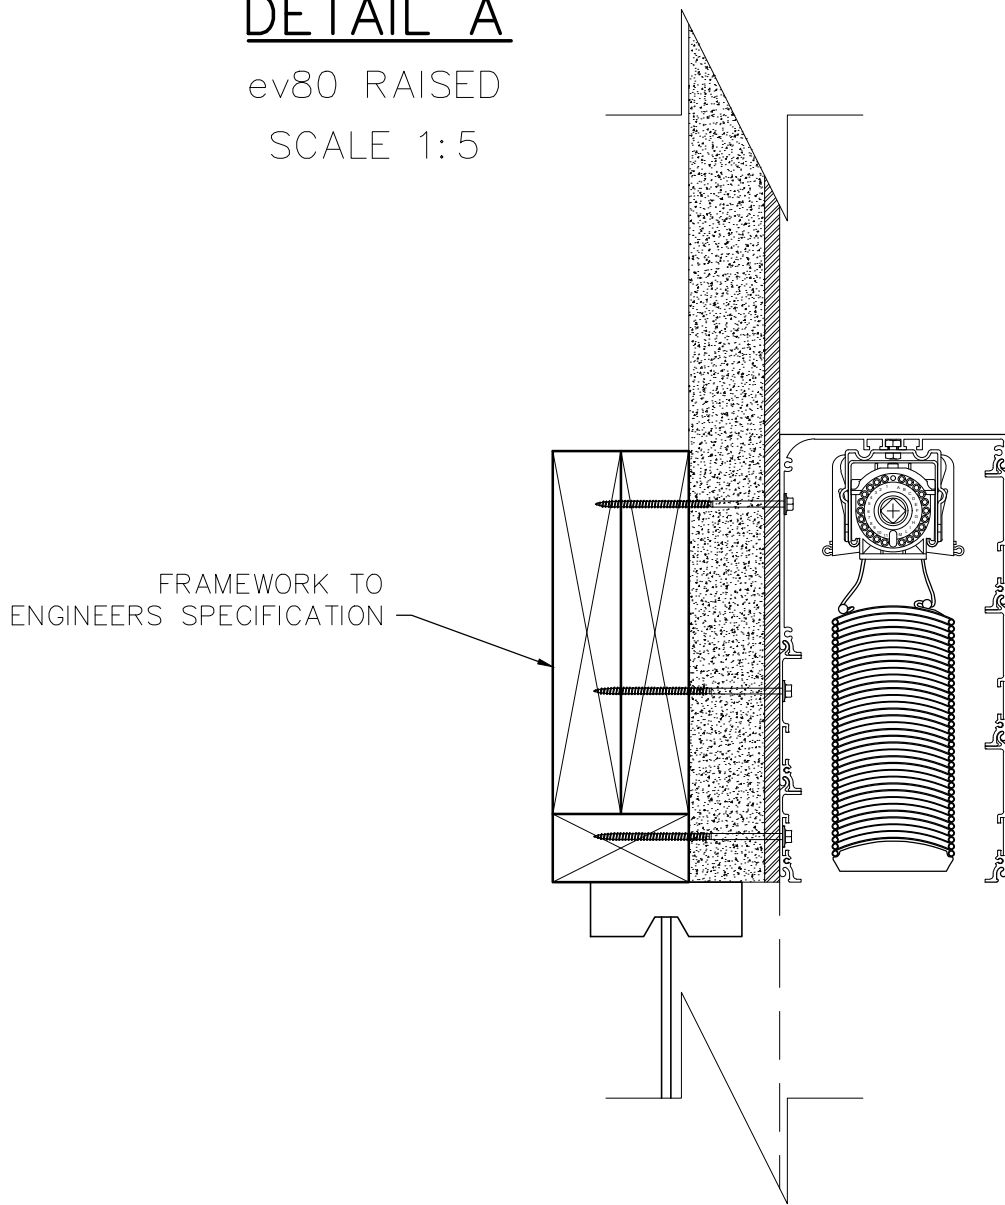

DETAIL B

PELMET END CAP
SCALE 1:5

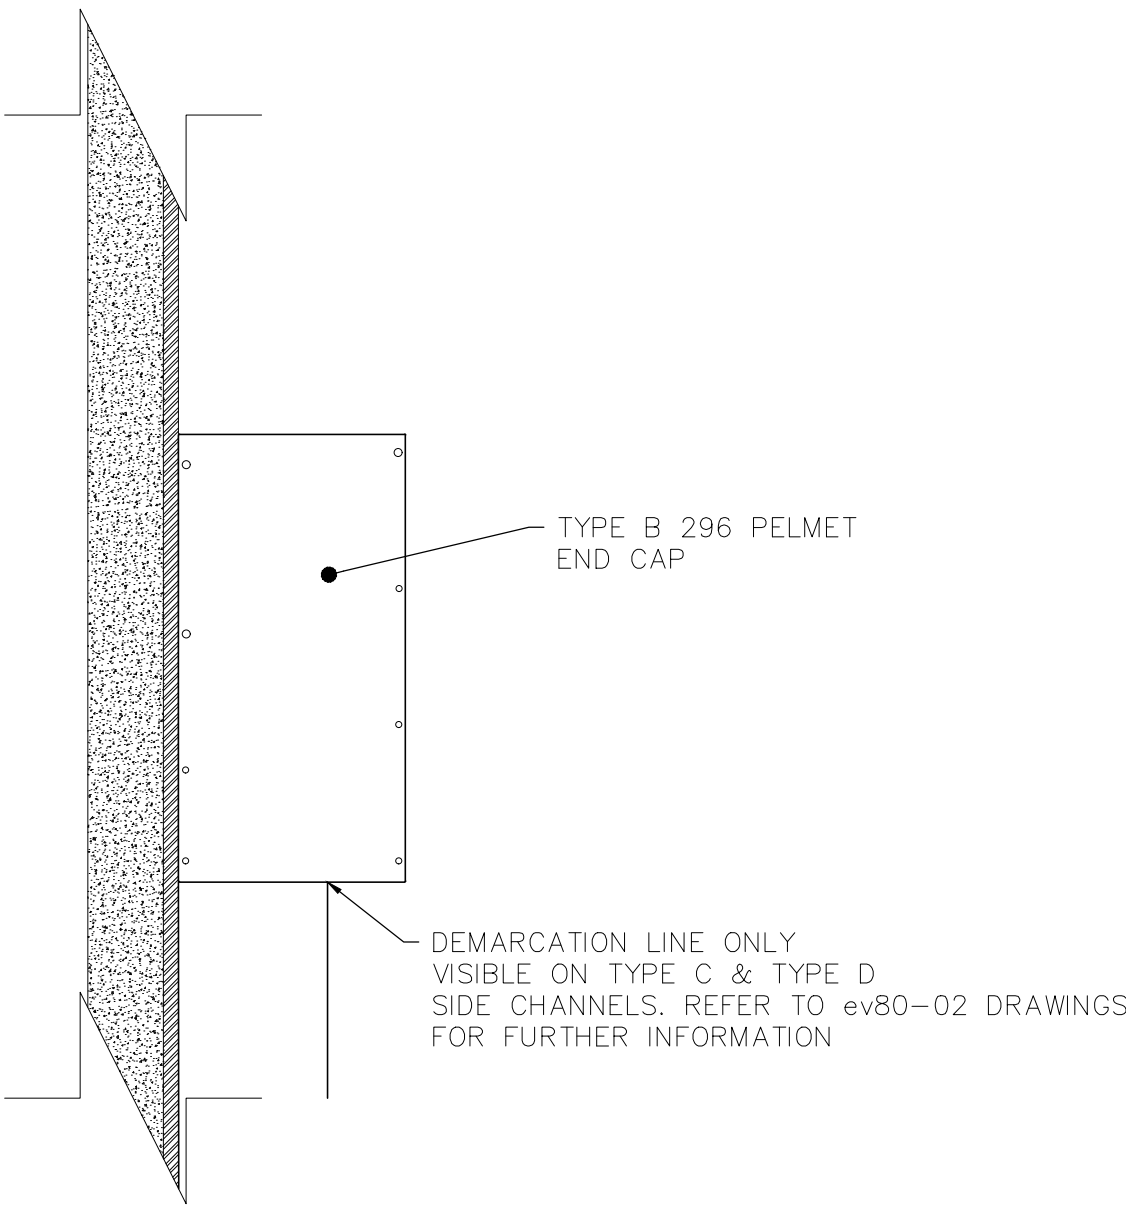

NOTES

- PELEMT DRAWN IS A TYPE B 296 PELMET WITH TYPE C CHANNELS, WINDOW IS 2400mm HIGH x 2400mm WIDE
- THE TYPE B 296 PELMET IS DESIGNED TO CONCEAL THE STACK HEIGHT OF THE ev80'S FOR WINDOWS UP TO 2400mm IN HEIGHT
- COMPATIBLE WITH ALL EVAYA CHANNEL TYPES, REFER TO DRAWING ev80-02 FOR FURTHER DETAIL
- TOP AND BACK FIXING POSSIBLE FOR FACE FIT AND RECESS APPLICATIONS, REFER TO DRAWING ev80-05-01 FOR FURTHER DETAIL
- DASHED AREA INDICATES RANGE OF MOTION OF THE ev80. THIS MUST REMAIN UNOBSTRUCTED
- OBSTACLES WHICH MAY CAUSE POSSIBLE INTERFERENCE INCLUDE:
 - OUTWARD OPENING AWNING WINDOWS
 - DOOR AND WINDOW HARDWARE
 - STORMBARS
 - ETC

evaya

EVAYA
4 SUFFOLK STREET, CAPEL SOUND, 3940, VIC AUSTRALIA
PHONE +61 (03) 5986 2183, SALES@EVAYA.COM.AU

THIS DRAWING MUST BE READ IN CONJUNCTION
WITH ALL OTHER RELEVANT DOCUMENTATION.
DO NOT SCALE DRAWINGS. CHECK AND VERIFY
ALL DIMENSIONS ON SITE PRIOR TO INSTALL.

THIS DRAWING MAY NOT BE COPIED,
COMMUNICATED TO ANY PERSON OR
USED FOR MANUFACTURE WITHOUT THE
EXPRESS WRITTEN CONSENT OF EVAYA.

TYPE B 296 PELMET

01 PELMET - TECHNICAL

SCALE 1:10 @ A1	DRAWING NO. ev80-01-04.A	SHEET 6 OF 20
BY SK	DATE AUG'25	CLIENT
CHECKED PA	DATE AUG'25	ADDRESS