


FRONT ELEVATION


TYPE B 386 PELMET WITH TYPE C SIDE CHANNELS

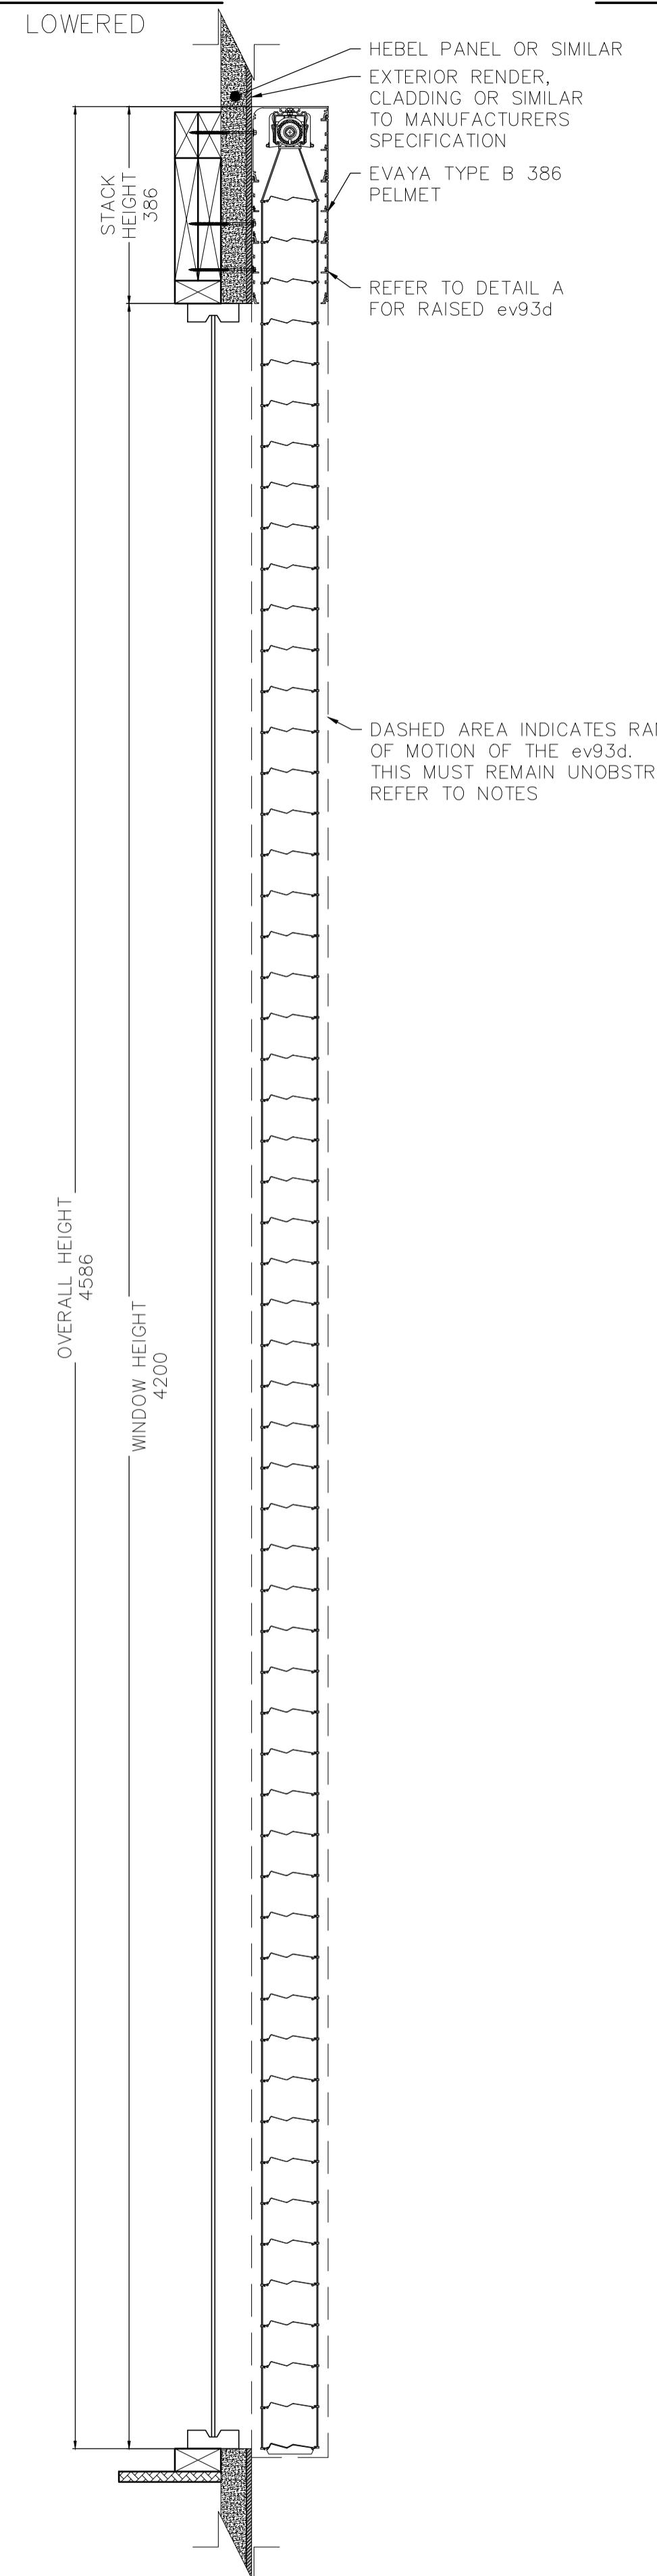

SECTION A-A




SECTION B-B

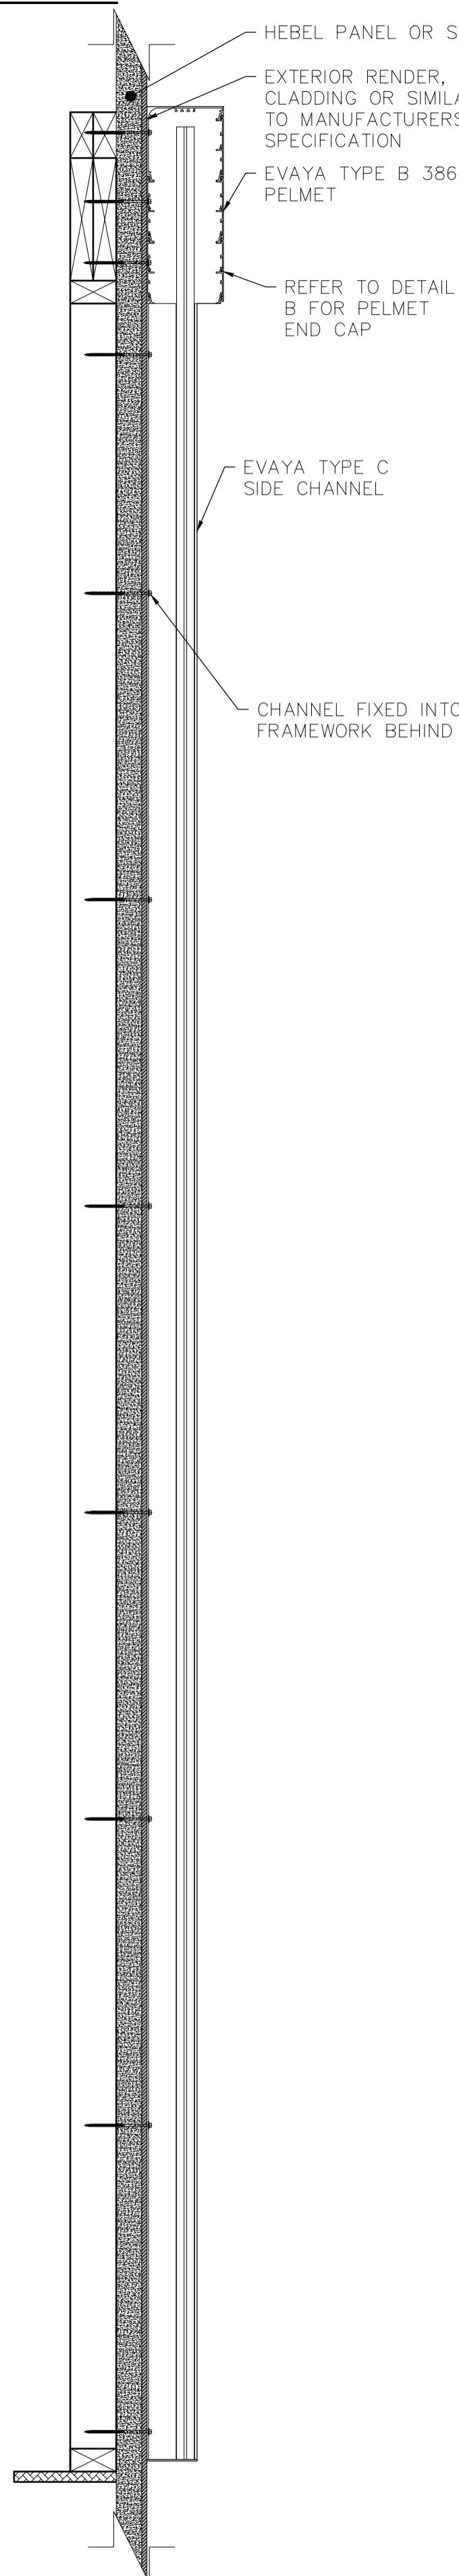

PELMET PROFILE

SCALE 1:1

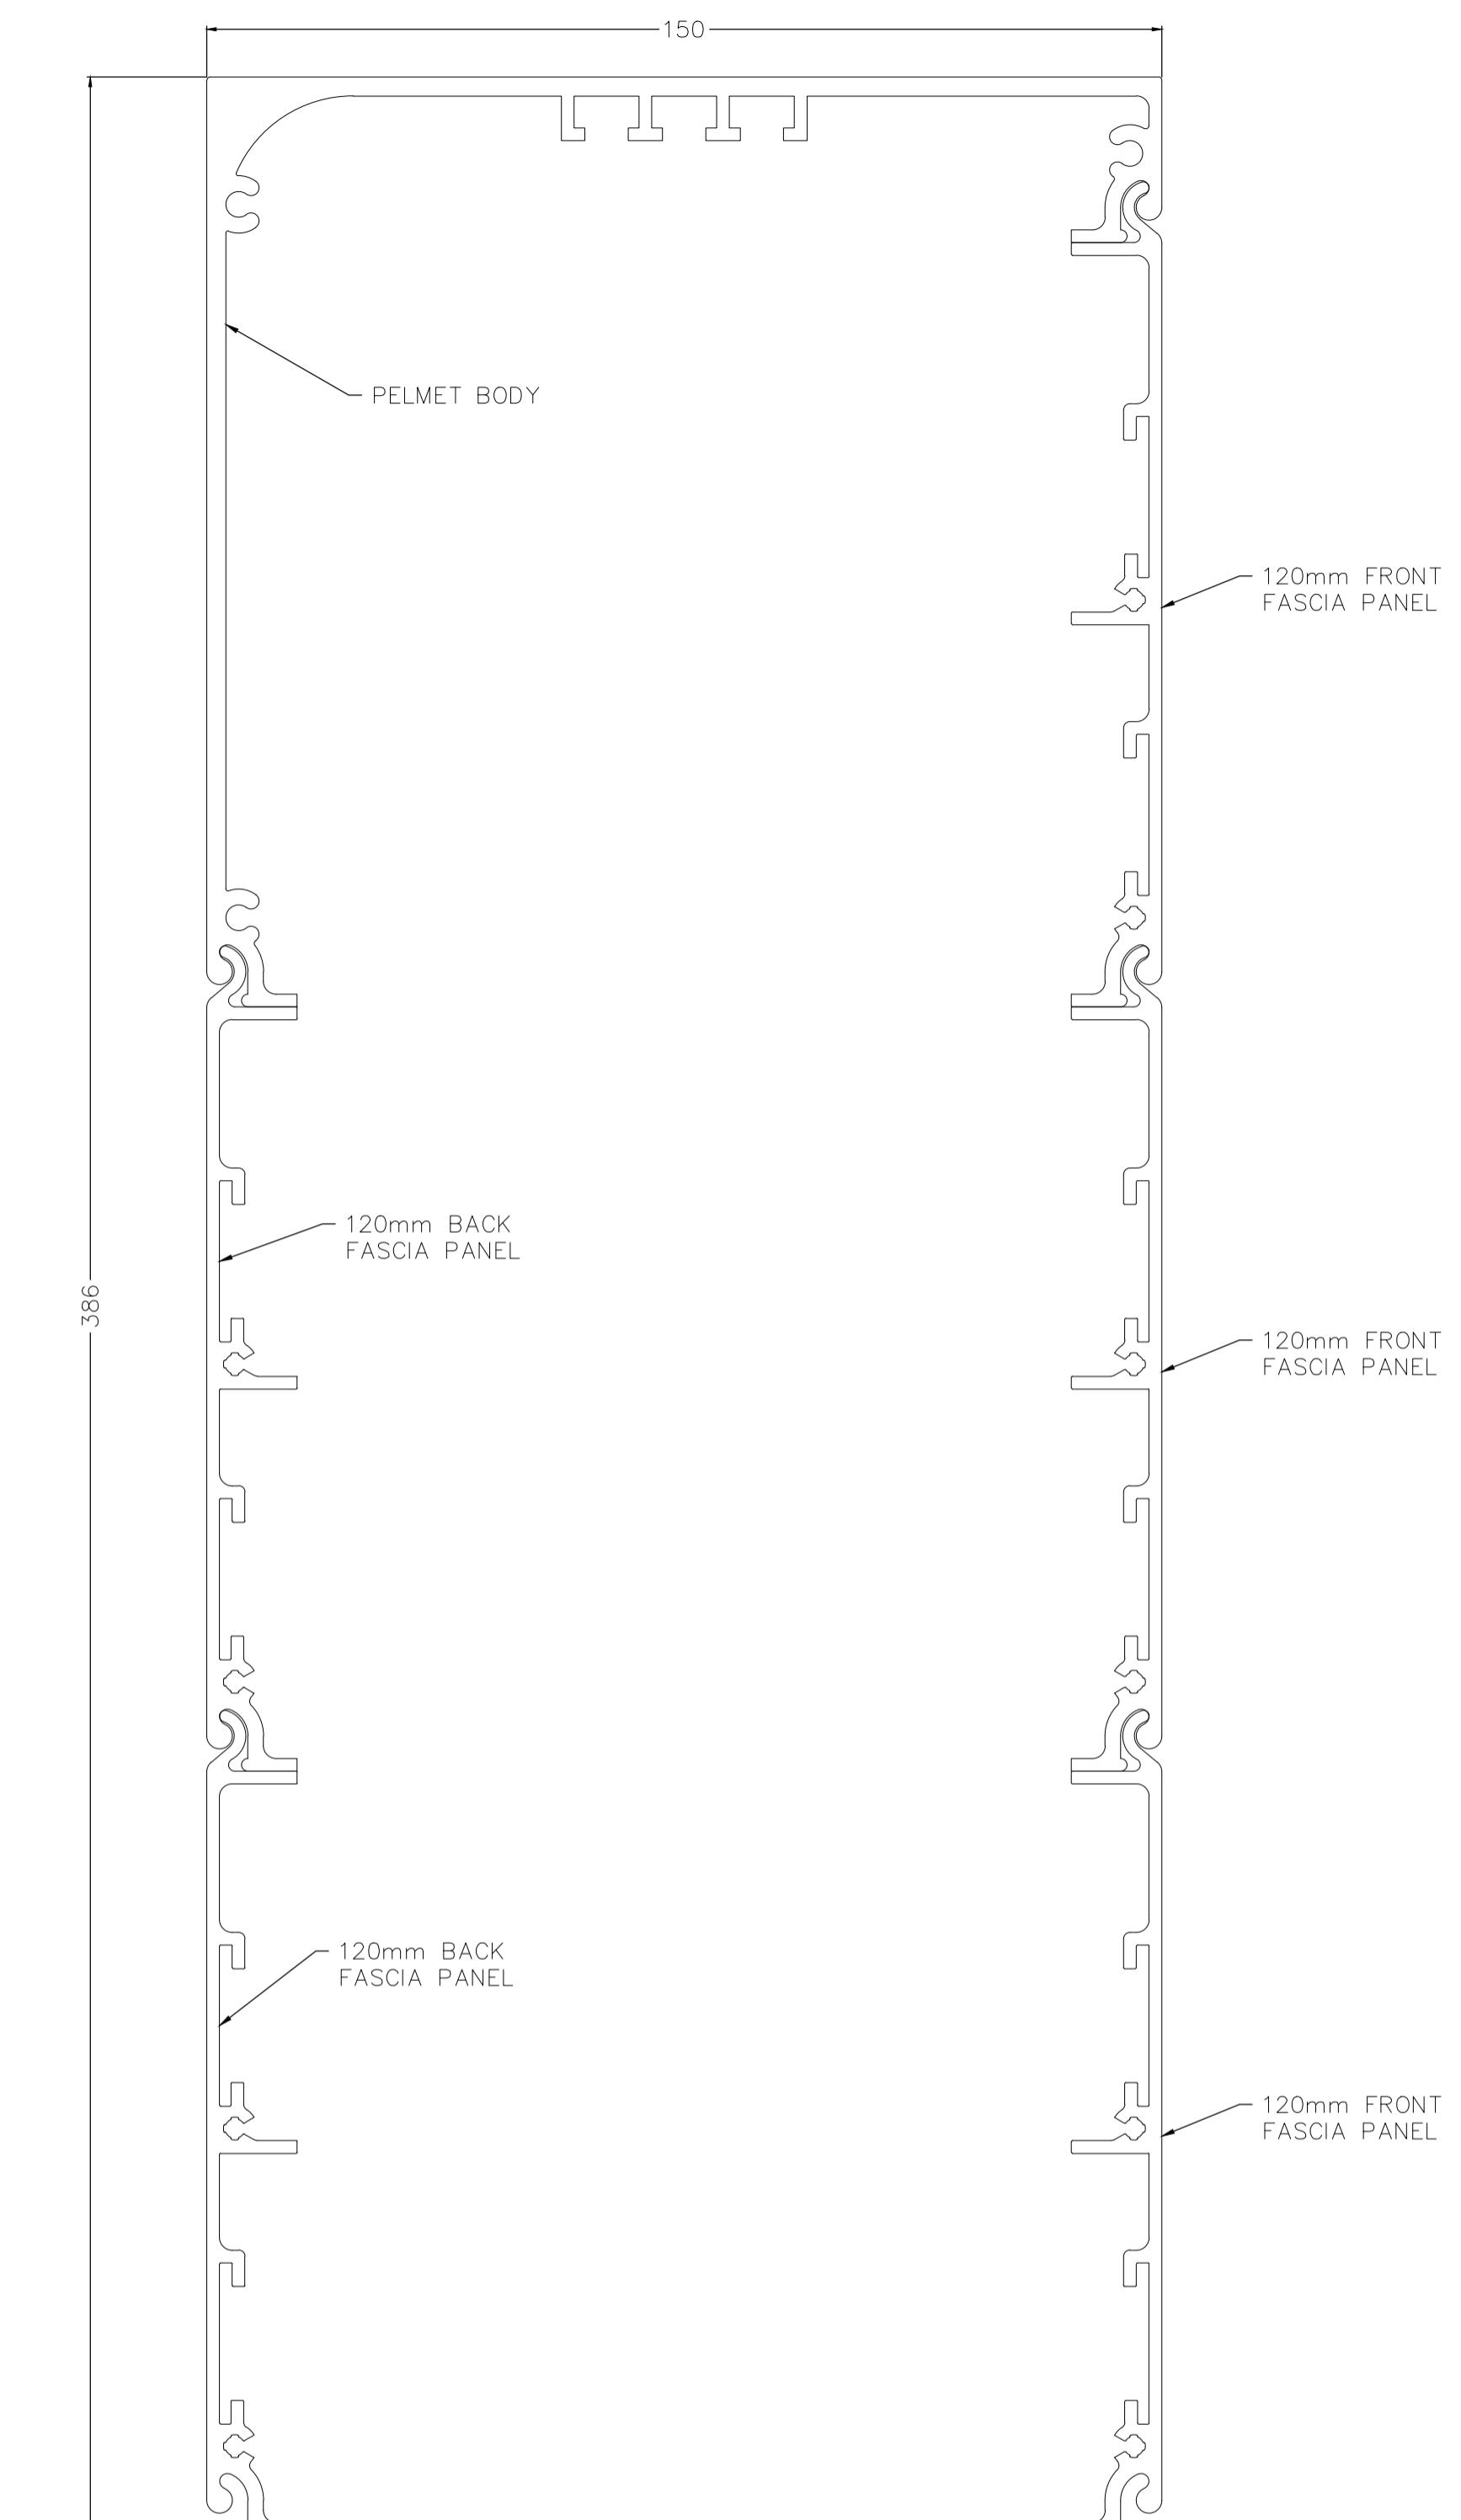

TYPE B 386 PELMET

01 PELMET - TECHNICAL

SCALE
1:10 @ A1

DRAWING NO
ev93d-01-05.A

SHEET
1 of 2

BY
SK

DATE
NOV'25

CLIENT



CHECKED
PA

DATE
NOV'25

ADDRESS

NOTES

- PELEMET DRAWN IS A TYPE B 386 PELMET WITH TYPE C CHANNELS, WINDOW IS 4200mm HIGH x 2400mm WIDE
- THE TYPE B 386 PELMET IS DESIGNED TO CONCEAL THE STACK HEIGHT OF THE ev93d'S FOR WINDOWS UP TO 4200mm IN HEIGHT
- COMPATIBLE WITH ALL EVAYA CHANNEL TYPES, REFER TO DRAWING ev93d-02 FOR FURTHER DETAIL
- TOP AND BACK FIXING POSSIBLE FOR FACE FIT AND RECESS APPLICATIONS, REFER TO DRAWING ev93d-05-01 FOR FURTHER DETAIL
- DASHED AREA INDICATES RANGE OF MOTION OF THE ev93d. THIS MUST REMAIN UNOBSTRUCTED
- OBSTACLES WHICH MAY CAUSE POSSIBLE INTERFERENCE INCLUDE:
 - OUTWARD OPENING AWNING WINDOWS
 - DOOR AND WINDOW HARDWARE
 - STORMBARS
 - ETC

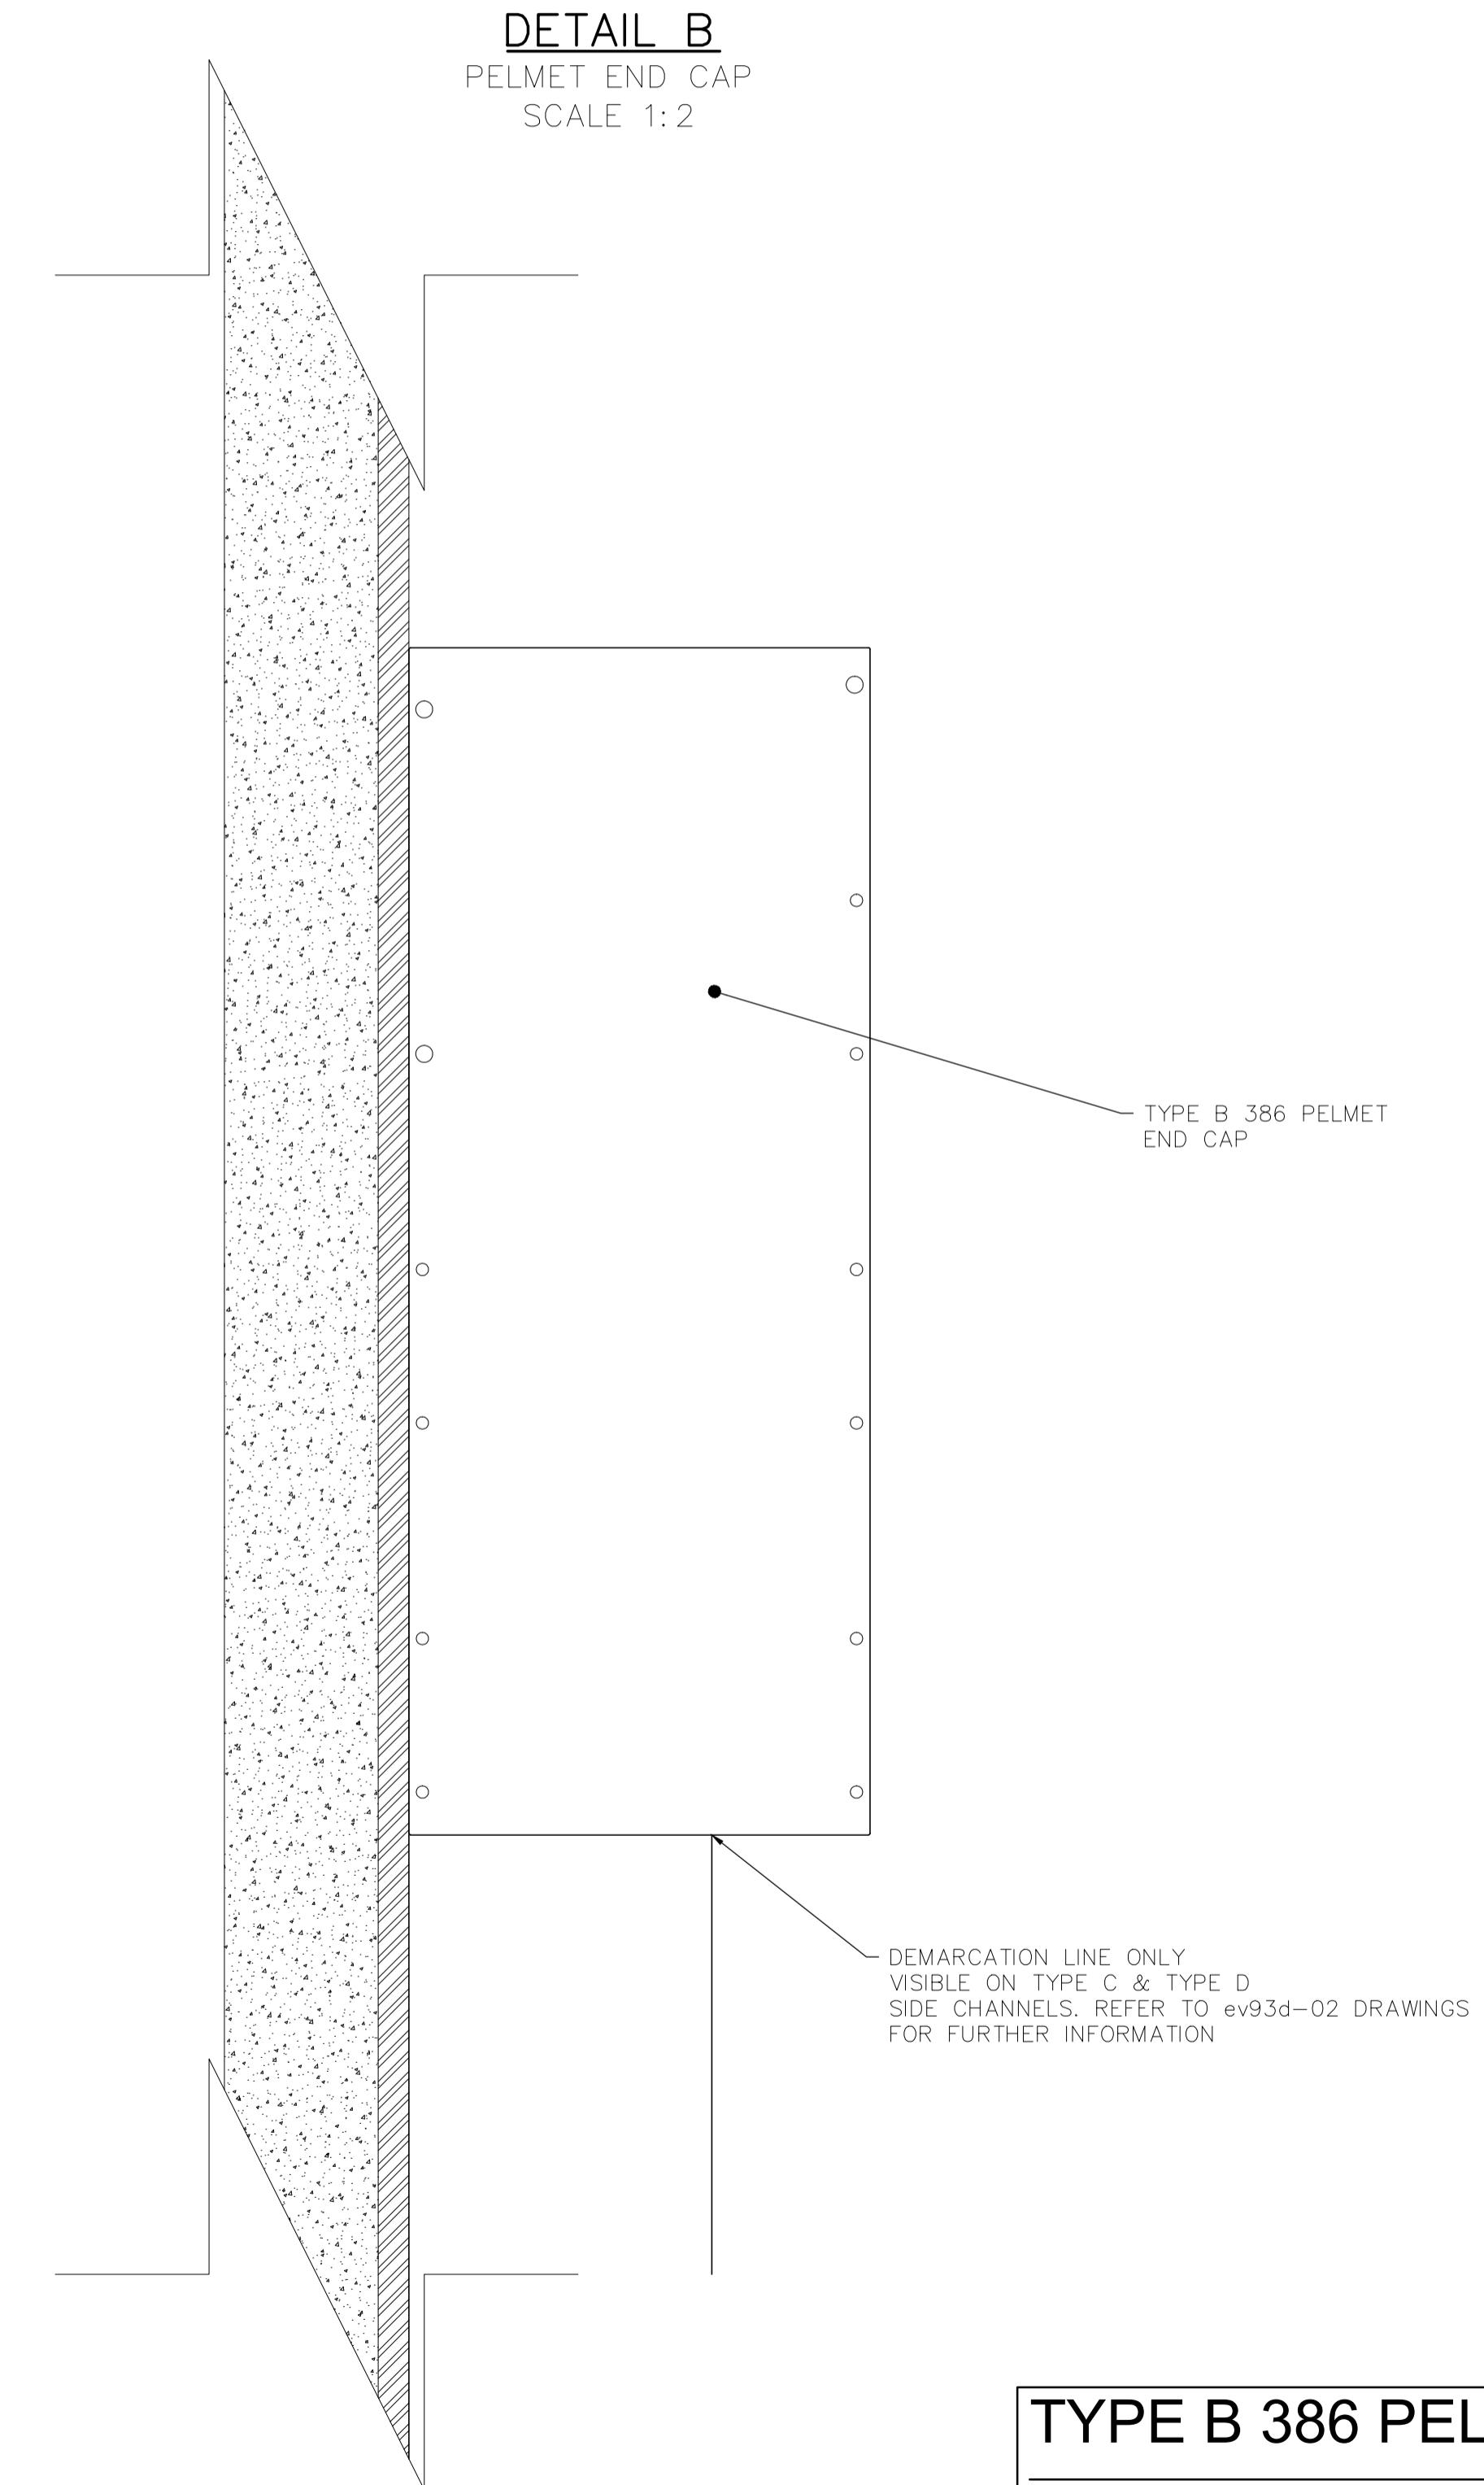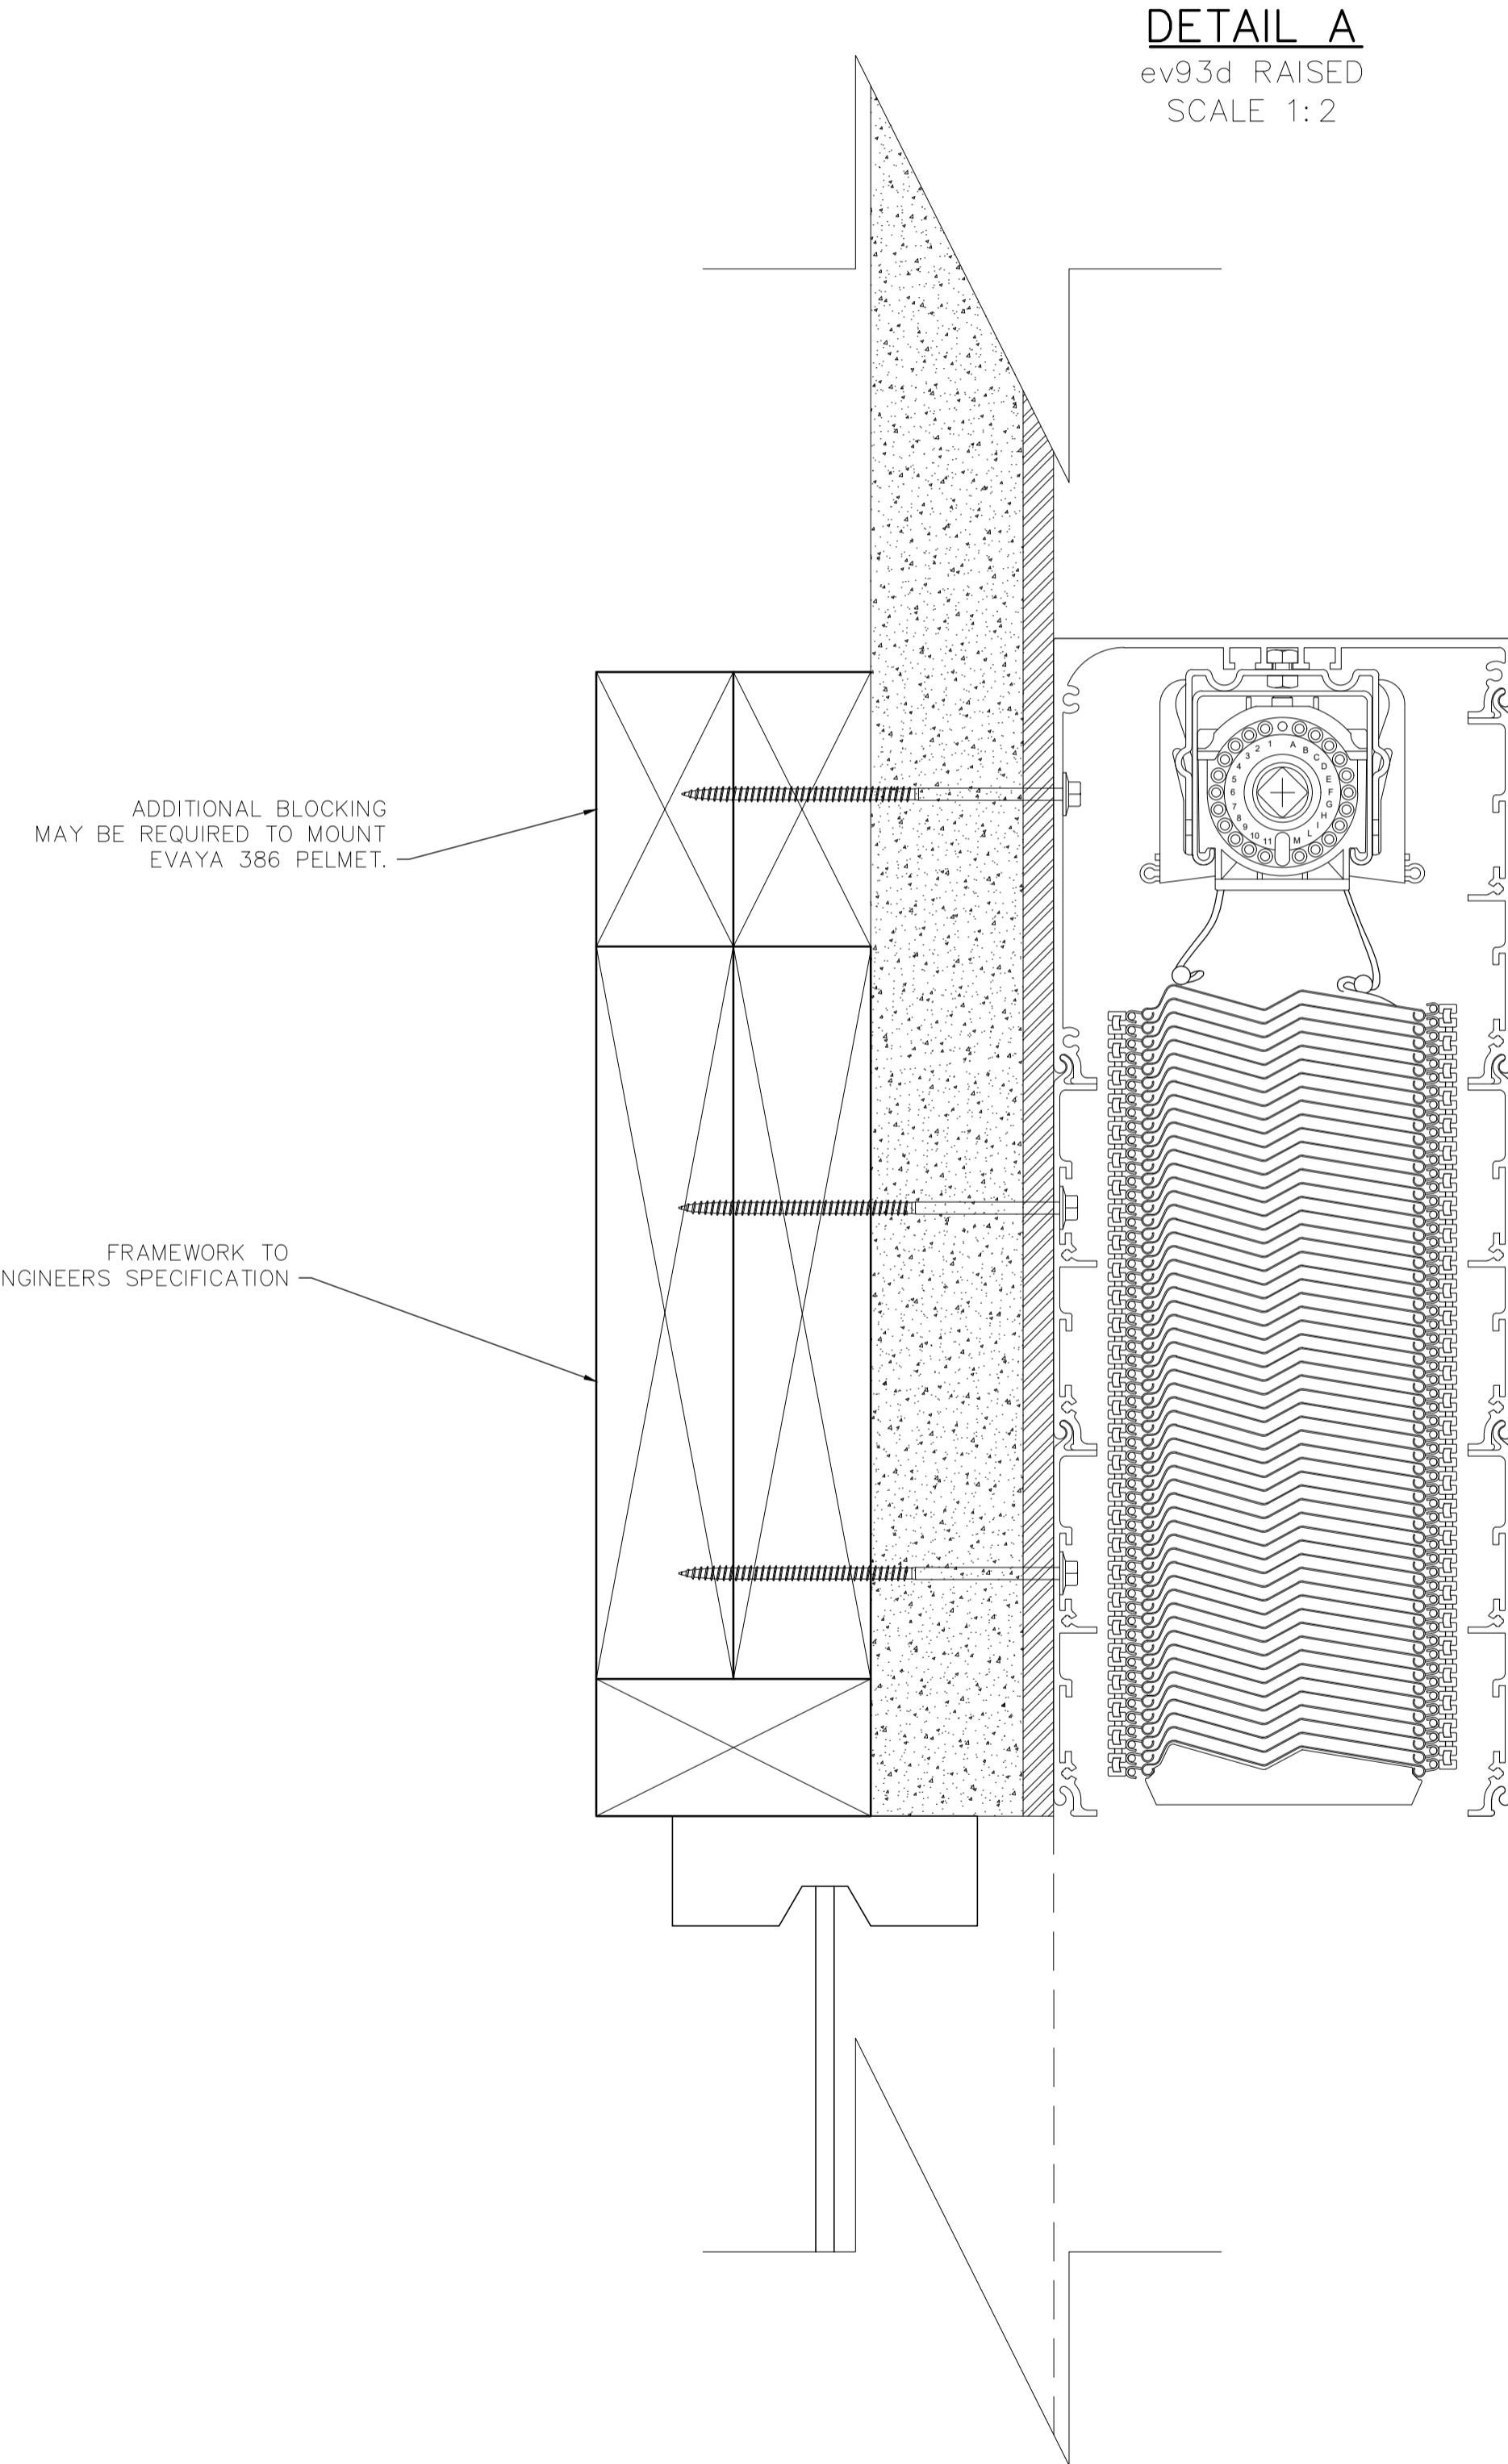

TYPE B 386 PELMET
01 PELMET - TECHNICAL

SCALE 1:10 @ A1	DRAWING NO ev93d-01-05.A	CLIENT 2 of 2
BY SK	DATE NOV'25	
CHECKED PA	DATE NOV'25	ADDRESS